



PROJECT:JOHNSON SPRINGVIEW PARK

LOCATION:ROCKLIN, CA

BUILDING TYPE: REK 22X70

ROOF TYPE: MULTI-RIB

BUILDING NUMBER: P10425

ORDER NUMBER: 66131

DRAWING LIST:

SHEET NUMBER	DRAWING DESCRIPTION
CS	COVER SHEET
1	ARCHITECTURAL ELEVATIONS
2	STRUCTURAL FRAMING PLAN
3	COLUMN LAYOUT

FABRICATOR APPROVALS:
CITY OF PHOENIX, AZ APPROVED FABRICATOR #C08-2010
CITY OF LOS ANGELES, CA APPROVED FABRICATOR #1596
CITY OF RIVERSIDE, CA APPROVED FABRICATOR #SP06-0033
CITY OF HOUSTON, TX APPROVED FABRICATOR #470
CLARK COUNTY, NV APPROVED FABRICATOR #264
STATE OF UTAH APPROVED FABRICATOR 02008-14

CERTIFICATES:
MIAMI-DADE COUNTY CERTIFICATE OF COMPETENCY NO. 16-1025.01
PCI (POWDER COATING INSTITUTE) 4000 CERTIFIED


MATERIALS:

DESCRIPTION	ASTM DESIGNATION
TUBE STEEL	A500 (GRADE B)
SCHEDULE PIPE	A53 (GRADE B)
RMT PIPE	A519
LIGHT GAGE COLD FORMED	A1003 (GRADE 50)
STRUCTURAL STEEL PLATE	A36
ROOF PANELS (STEEL)	A653

STOP!!

NOT FOR CONSTRUCTION

USE FOR PRELIMINARY
PLANNING AND ESTIMATING
ONLY

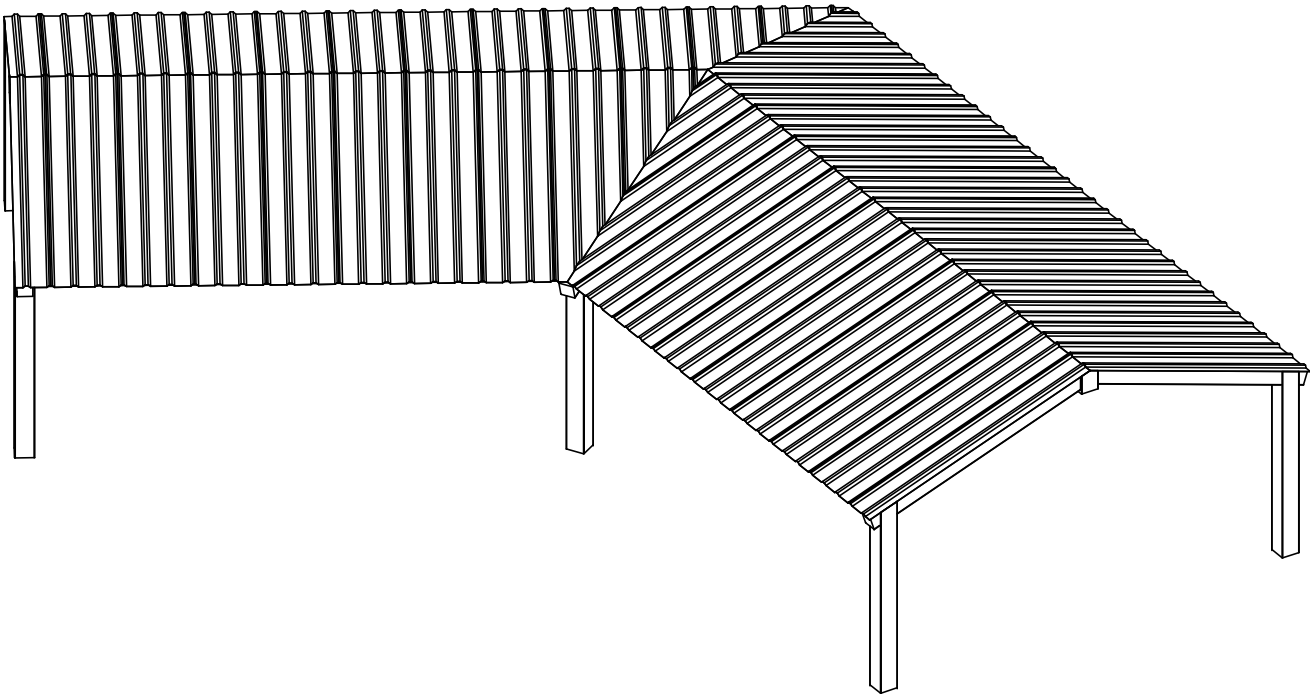

GENERAL NOTES:
UNLESS NOTED OTHERWISE, THIS STRUCTURE WAS DESIGNED TO ONLY SUPPORT WHAT IS SHOWN ON THESE DRAWINGS. POLIGON MUST BE CONTACTED IF ANYTHING ELSE IS TO BE ATTACHED TO THIS STRUCTURE (WALLS, COLUMN WRAPS, RAILINGS, ETC.) SO THE DESIGN OF THIS STRUCTURE CAN BE REVIEWED AND POSSIBLY REVISED.

UNLESS NOTED OTHERWISE, THIS STRUCTURE WAS DESIGNED ASSUMING A 20' SEPARATION BETWEEN ANY ADJACENT STRUCTURE WITH AN EAVE HEIGHT EQUAL TO OR GREATER THAN THE EAVE HEIGHT OF THIS STRUCTURE. IF THAT SEPARATION DOES NOT EXIST, POLIGON MUST BE CONTACTED SO THE DESIGN OF THIS STRUCTURE CAN BE REVIEWED AND POSSIBLY REVISED.

STRUCTURAL STEEL SHALL BE DETAILED, FABRICATED, AND ERECTED IN ACCORDANCE WITH THE LATEST EDITION OF THE AMERICAN INSTITUTE OF STEEL CONSTRUCTION (AISC) SPECIFICATION MANUAL.

ALL WELDING IS PERFORMED BY AMERICAN WELDING SOCIETY CERTIFIED WELDERS AND CONFORMS TO THE LATEST EDITION OF AWS D1.1 OR D1.3 AS REQUIRED.

PARTS SHOWN MAY BE UPGRADED DUE TO STANDARDIZED FABRICATION. REFER TO THE SHIPPING BILL OF MATERIALS FOR POSSIBLE SUBSTITUTIONS.

FOR PROPER FIELD INSTALLATION OF THE BUILDING IT IS RECOMMENDED THAT THE PRIMARY FRAME INSTALLER AND THE ROOF INSTALLER HAVE A MINIMUM FIVE (5) YEARS DOCUMENTED EXPERIENCE INSTALLING THIS TYPE OF PRODUCT.

FOR PROPER FIELD INSTALLATION OF THE BUILDING IT IS RECOMMENDED THAT ELECTRIC WIRING, IF REQUIRED, BE RUN THROUGH THE STRUCTURAL MEMBERS BEFORE THE BUILDING IS ERECTED.

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REV LEVEL:

A

DRAWN BY:

chris.lisac

PRINT DATE:

10/31/2019

JOB NO:

P10425

CAD MODEL:

~P10425

SCALE:

1:96

PROJECT:

JOHNSON SPRINGVIEW PARK

PROJECT LOCATION:


ROCKLIN, CA

DRAWING:


COVER SHEET

SHEET

CS

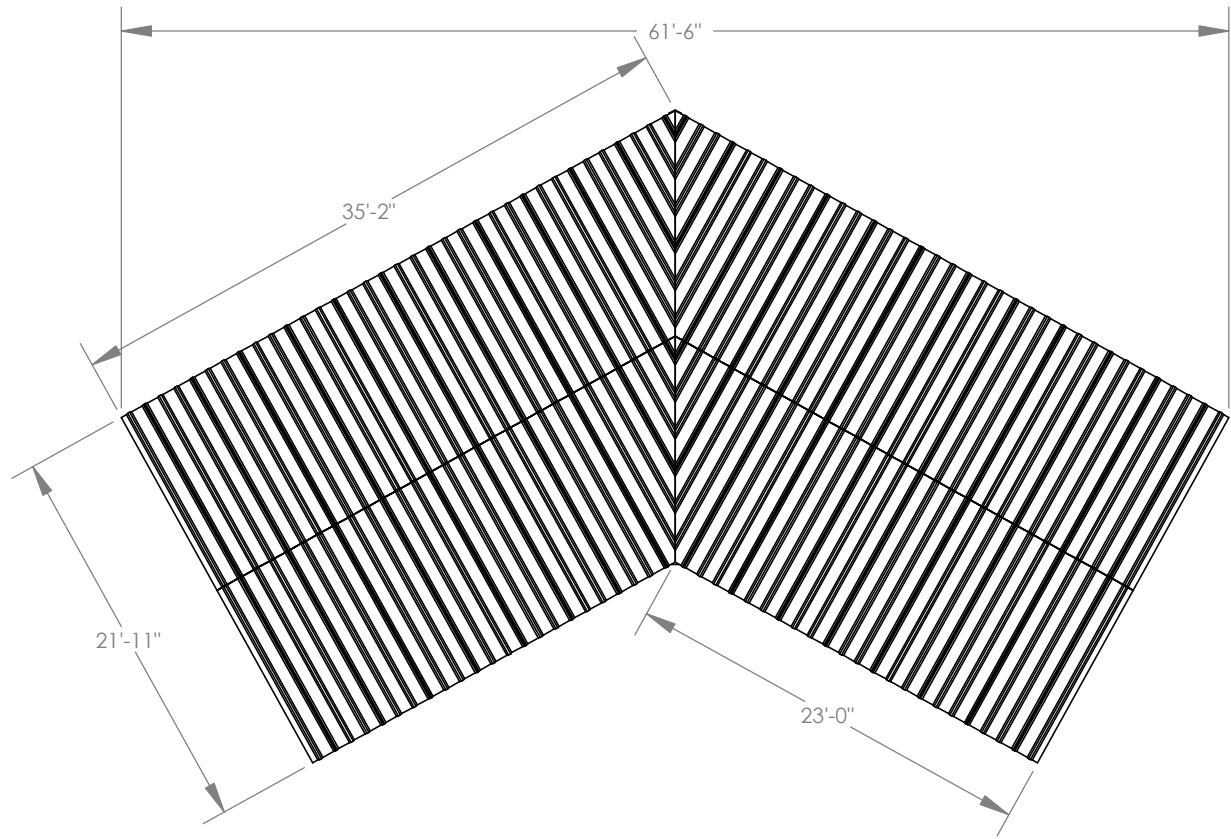


TOP VIEW

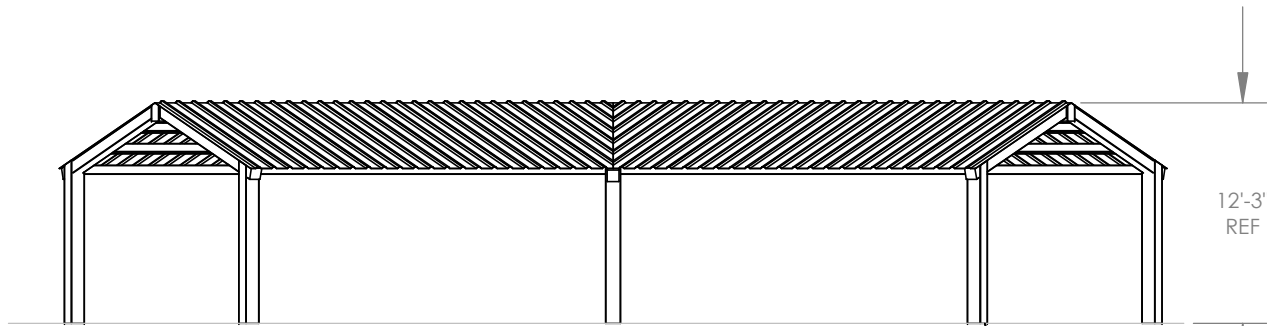


FRONT VIEW

FINISH GRADE
(ASSUMED AT CONSTANT
ELEVATION UNLESS
OTHERWISE NOTED)

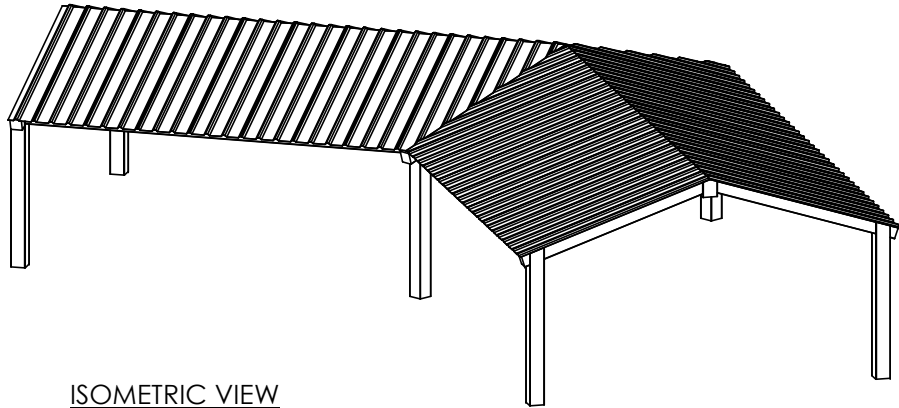

ISOMETRIC VIEW

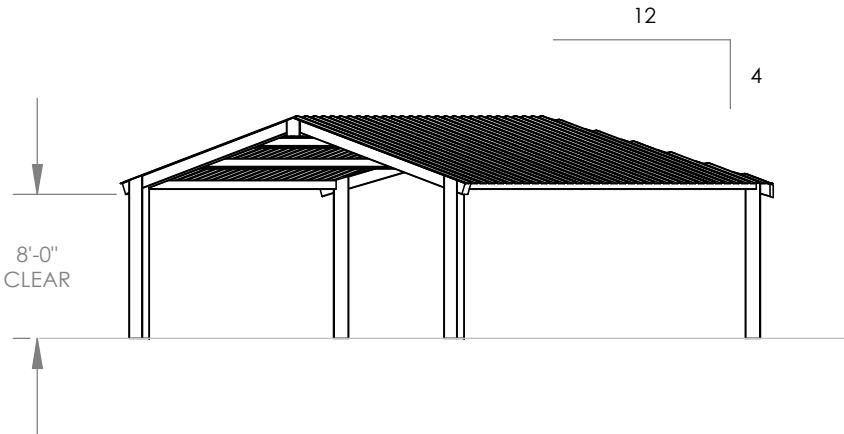

SIDE VIEW


GENERAL ROOF NOTES:

1. METAL ROOFING:
 - 24 GAUGE
 - GALVALUME COATED
 - KYNAR 500 PAINTED
2. TRIM COLOR MATCHES ROOF
3. SEE POLIGON.COM FOR COLOR OPTIONS


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1	SHEET	PROJECT: JOHNSON SPRINGVIEW PARK	PRINT DATE: 10/31/2019	DRAWN BY: chris.lisac	REV LEVEL: A	<div>poligon[®]</div> <div>(616)399-1963</div> <div>www.poligon.com</div> <div>by PORTERCORP</div> <div>COPYRIGHT 2016</div> <div>PATENTED OR PATENTS PENDING</div> <div>PORTERCORP 4240 N. 136th AVE HOLLAND, MI 49424</div>
		PROJECT LOCATION: ROCKLIN, CA	JOB NO: P10425	SCALE: 1:128		
		DRAWING: ARCHITECTURAL ELEVATIONS	CAD MODEL: ~P10425			




TOP VIEW

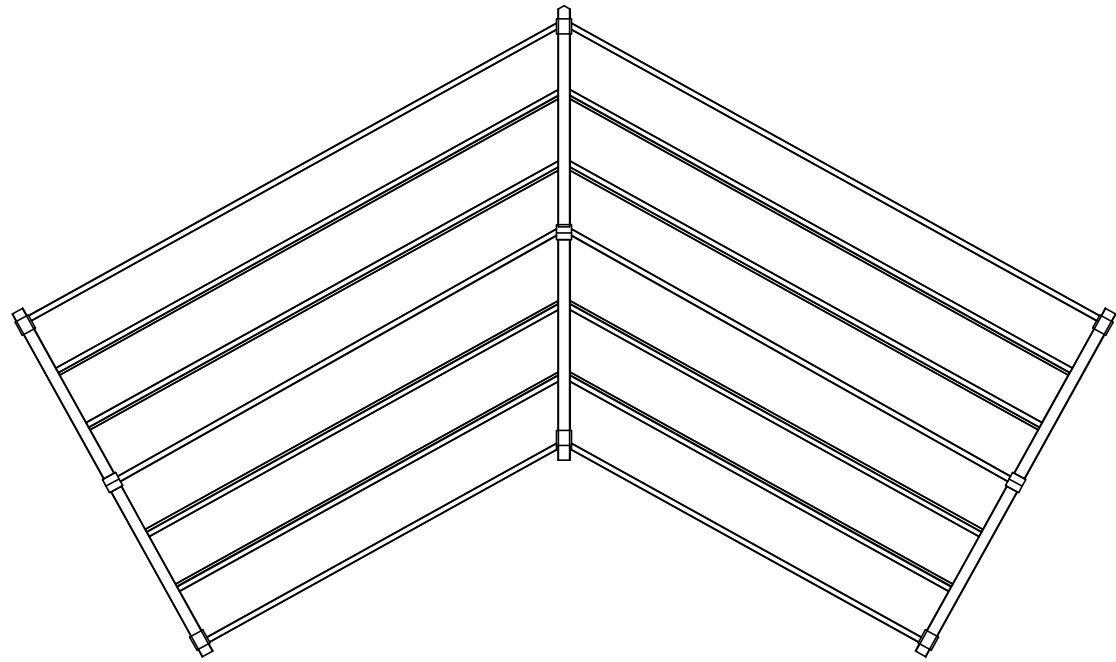


FRONT VIEW
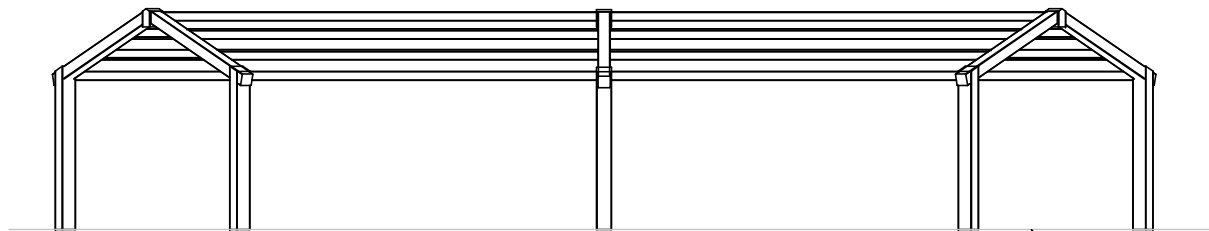
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ISOMETRIC VIEW

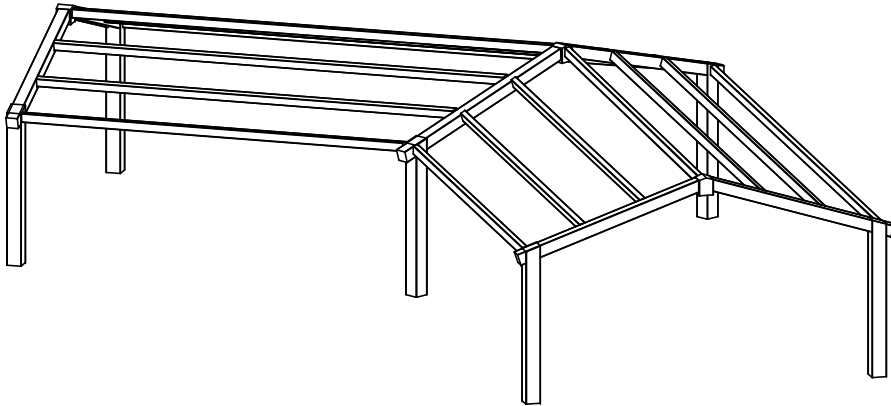

SIDE VIEW
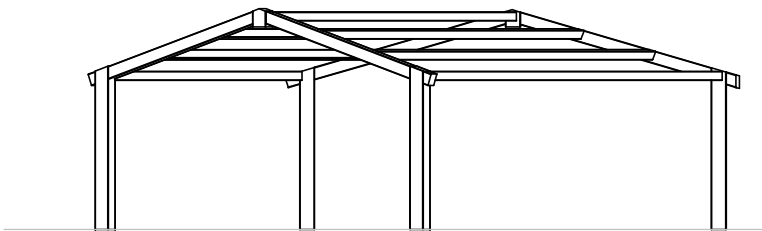
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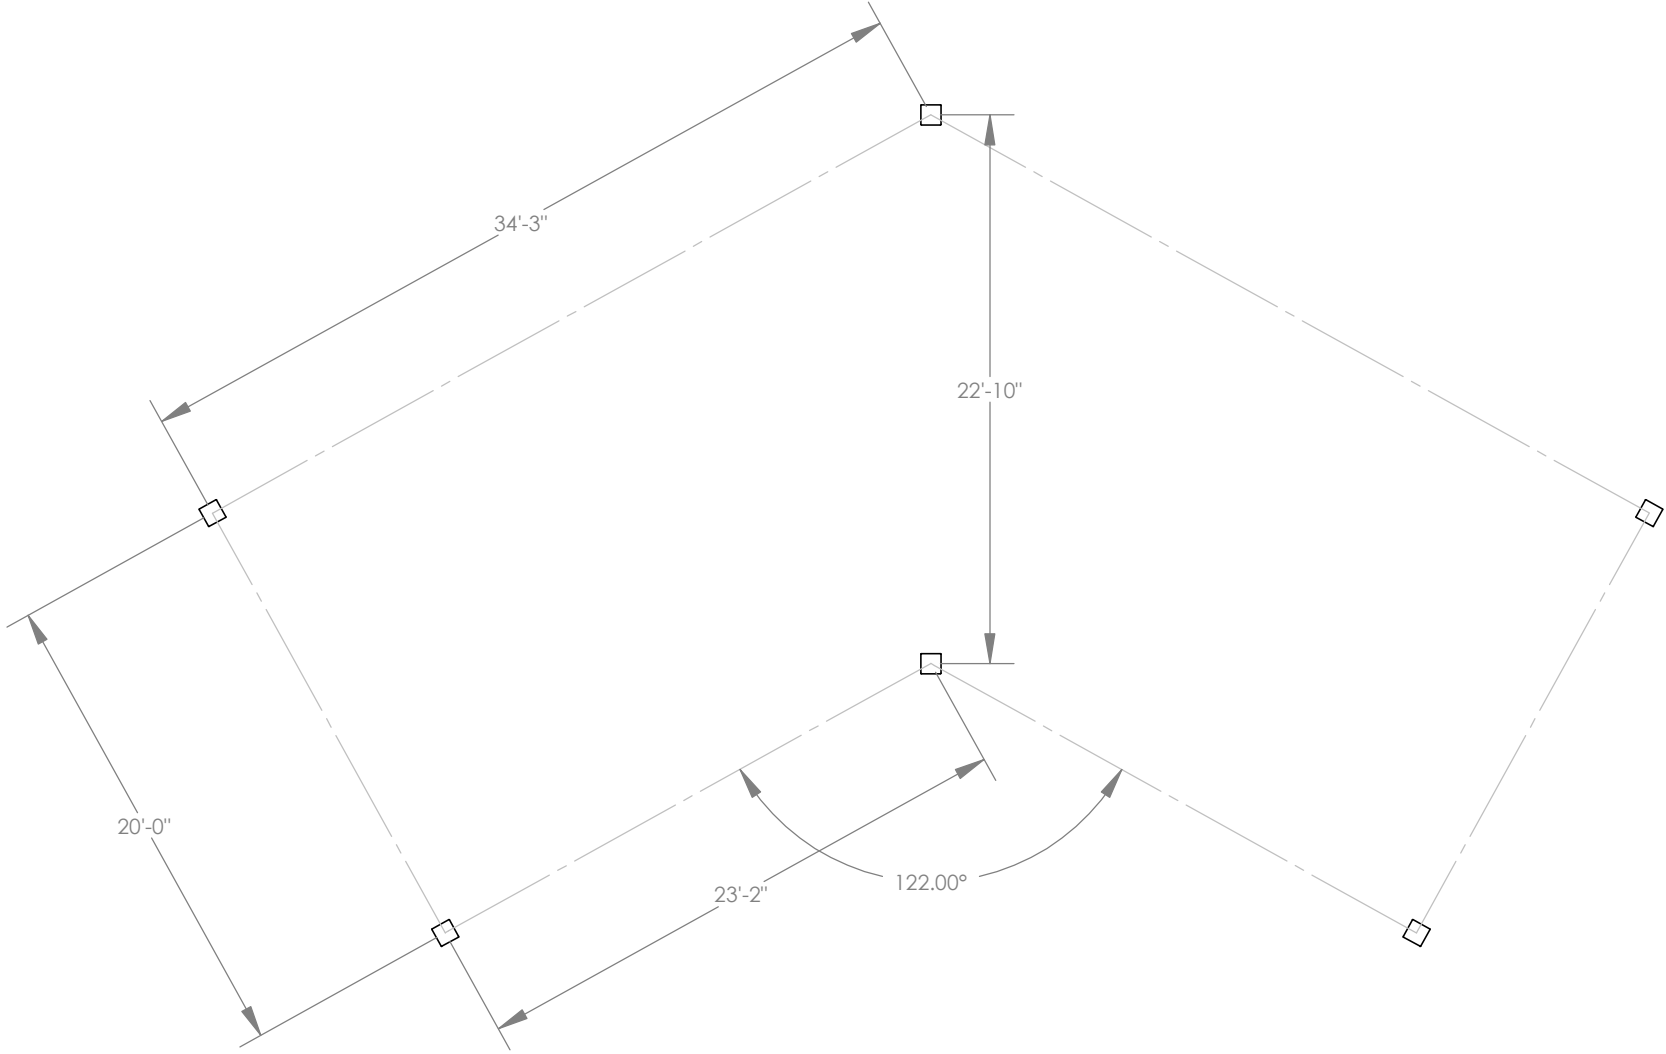
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PROJECT LOCATION:	ROCKLIN, CA	JOB NO:	P10425			SCALE:	1:128	www.poligon.com
DRAWING:	STRUCTURAL FRAMING PLAN	CAD MODEL:	~P10425					by PORTERCORP
SHEET								COPYRIGHT 2016 PATENTED OR PATENTS PENDING PORTERCORP 4240 N. 136th AVE HOLLAND, MI 49424
2								

STOP!!


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- BASEPLATE NOTES:**
- 1. POLYGON ENGINEERING WILL DETERMINE REQUIRED BASEPLATE DESIGN AFTER ENGINEERING PACKAGE IS ORDERED.
 - 2. CUSTOMER MAY SUGGEST PREFERRED BASEPLATE DESIGN.

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	JOB NO: P10425		SCALE: 1:96	
	DRAWING: COLUMN LAYOUT			
SHEET				3



FRAME COLOR: **ASH GRAY**
ROOF COLOR: **ROMAN BLUE**

COLORS SHOWN ARE FOR REFERENCE ONLY.
CONTACT [INFO@POLIGON.COM](mailto:info@poligon.com) TO REQUEST ACTUAL COLOR SAMPLES.

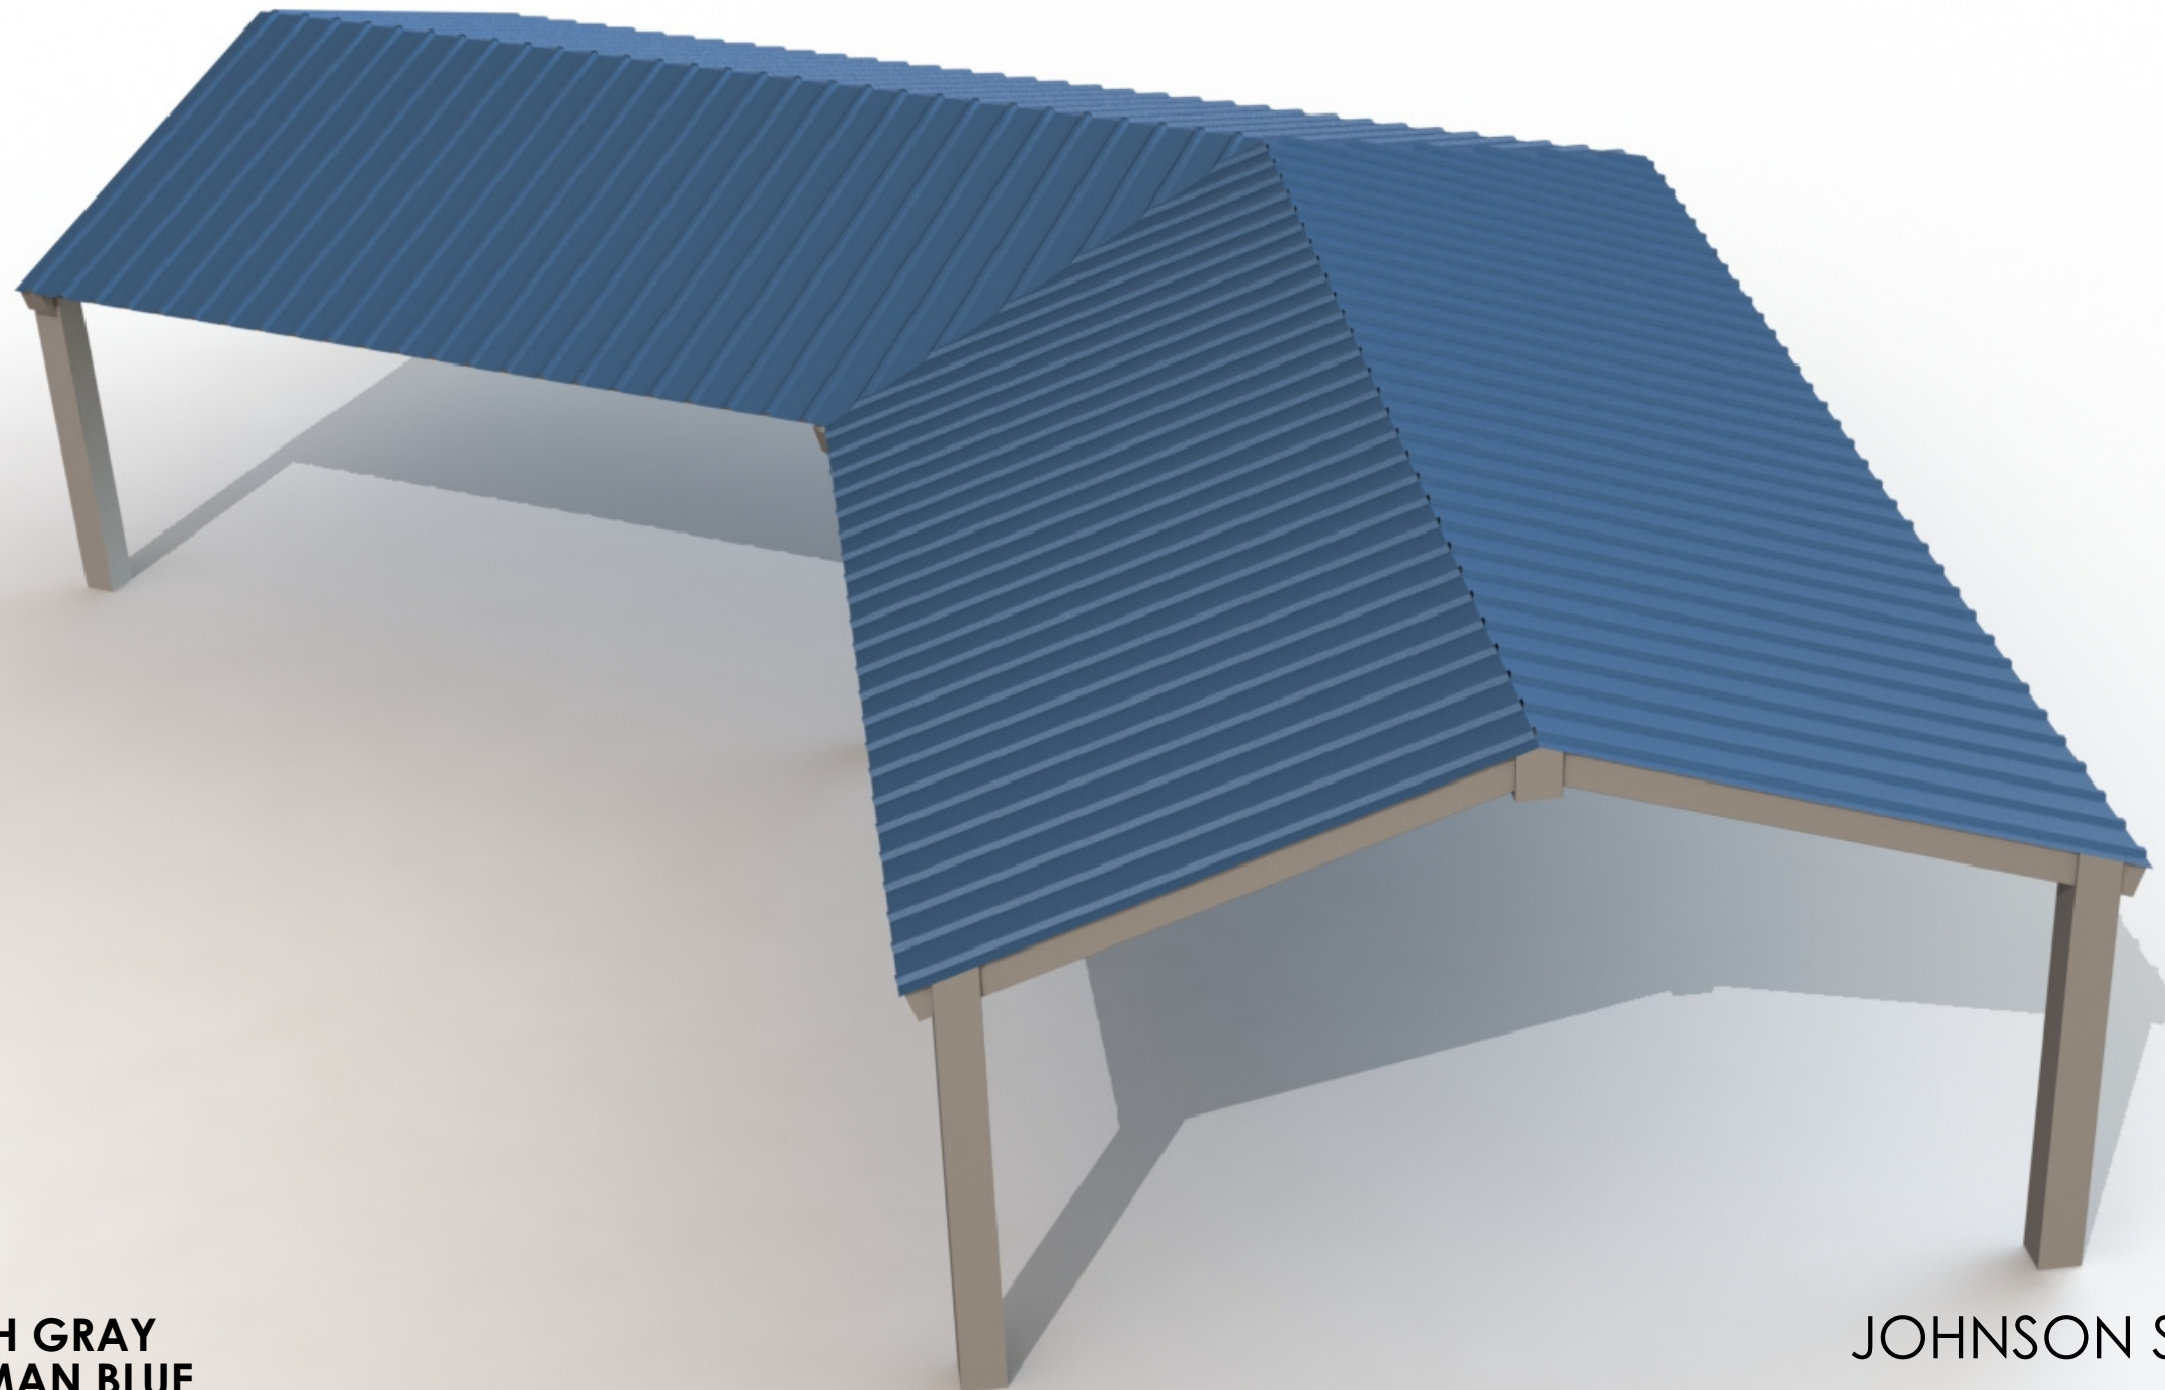JOHNSON SPRINGVIEW PARK

ROCKLIN, CA
REK 22X70